

SYMBOL	CONNECTIVITY	NETWORK	CABLE	CABLE COLOR	MTG. ELEVATION DWG. ET401
$\nabla_{W}$	VOIP PHONE (1)	DATA/TELE	CATEGORY 6	BLUE	DETAIL 1
▼	DATA DROPS (2)	DATA/TELE	CATEGORY 6	BLUE	DETAIL 2
lacksquareA	DATA DROPS (2)	DATA/TELE	CATEGORY 6	BLUE	DETAIL 3
lacksquareB	DATA DROP (1)	DATA/TELE	CATEGORY 6	BLUE	DETAIL 4
$\blacktriangledown_{C}$	DATA DROP (1)	DATA/TELE	CATEGORY 6	BLUE	DETAIL 5
<b>▼</b> CA	DATA DROP (2)	DATA/TELE	CATEGORY 6	BLUE	DETAIL 6
lacksquare	DATA DROPS (4)	DATA/TELE	CATEGORY 6	BLUE	DETAIL 7
▼E	DATA DROPS (4)	VI SYSTEM	CATEGORY 6	RED	DETAIL 8
▼ <sub>F</sub>	DATA DROPS (4)	DATA/TELE	CATEGORY 6	BLUE	DETAIL 9
$lacksquare$ _G	DATA DROPS (1) TELEVISION (1)	DATA/CATV	CATEGORY 6 COAXIAL	BLUE BLACK	DETAIL 10
$\nabla_{\!P}$	ANALOG PHONE (1)	PHONE	CATEGORY 6	YELLOW (	DETAIL 11
$lacktriangledown_{RA}$	ANTENNA DROPS (4)	RADIO	COAXIAL	BLACK	DETAIL 12
$\nabla_{\!\scriptscriptstyle{\mathrm{RJ}}}$	ANALOG PHONE (1)	PHONE	CATEGORY 6	YELLOW	DETAIL 13
lacksquareVI	CAMERA DROP (1)	VIDEO INTER	CATEGORY 6	RED	DETAIL 14
lacksquare	CAMERA DROP (1)	SECURITY	CATEGORY 6	WHITE	DETAIL 15
lacksquareWE	CAMERA DROP (1)	SECURITY	CATEGORY 6	WHITE	DETAIL 16
lacksquareX	MONITOR DROP (2)	SECURITY	CATEGORY 6	WHITE	DETAIL 17
$lacktriangledown_{XX}$	INTERCOM DROP (1)	SECURITY	CATEGORY 6	WHITE	DETAIL 18
$lacktriangledown_{Z}$	INTERCOM DROP (1)	SECURITY	CATEGORY 6	WHITE(	DETAIL 19
$lackbox{lackbox{$\nabla$}}$	DATA DROPS (2) ANALOG PHONE (1)	DATA/TELE PHONE	CATEGORY 6 CATEGORY 6	BLUE YELLOW	DETAIL 20
	CAMERA DROP (1)	SECURITY	CATEGORY 6	WHITE (	DETAIL 21
	DATA DROPS (2)	DATA/TELE	CATEGORY 6	BLUE	DETAIL 22
WAP	DATA DROP (2)	DATA/TELE	CATEGORY 6	BLUE	DETAIL 23
17)	DATA DROP (2) TELEVISION (1)	DATA /CATV	CATEGORY 6 COAXIAL	BLUE BLACK	DETAIL 24
(TV) A	CATV (4)	CATV	COAXIAL	BLACK\	DETAIL 25

NOTE: NOT ALL SYMBOLS APPEAR ON DRAWING. SYMBOLS HAVE BEEN PROVIDED FOR REFERENCE PURPOSES ONLY. REFER TO DRAWING ET401 AND RELATED SPECIFICATION SECTIONS FOR ADDITIONAL INFORMATION

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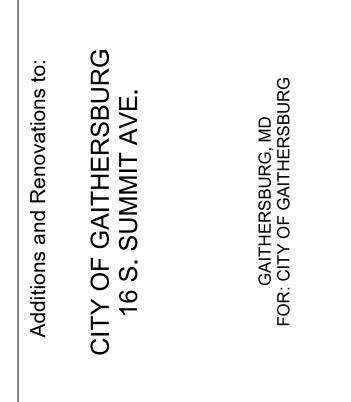
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Professional Seal:


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City of Gaithersburg, MD

31 South Summit Avenue
Gaithersburg, MD 20877



NO.	DESCRIPTION	DATE
	ISSUED FOR BID	07/16/20
<u> </u>	ADDENDUM 1	11/01/20
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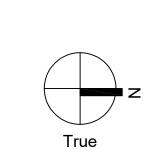



Drawn By: AJF Checked By: AJF

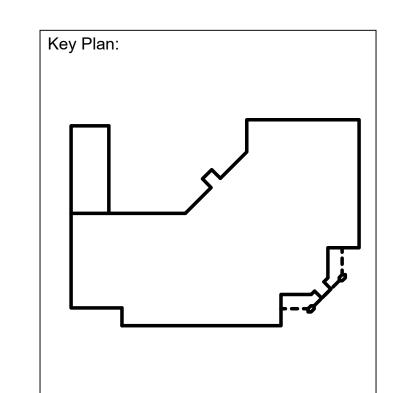Drawing Title:

TELECOMMUNICATIONS FIRST FLOOR PLAN

Drawing Number:



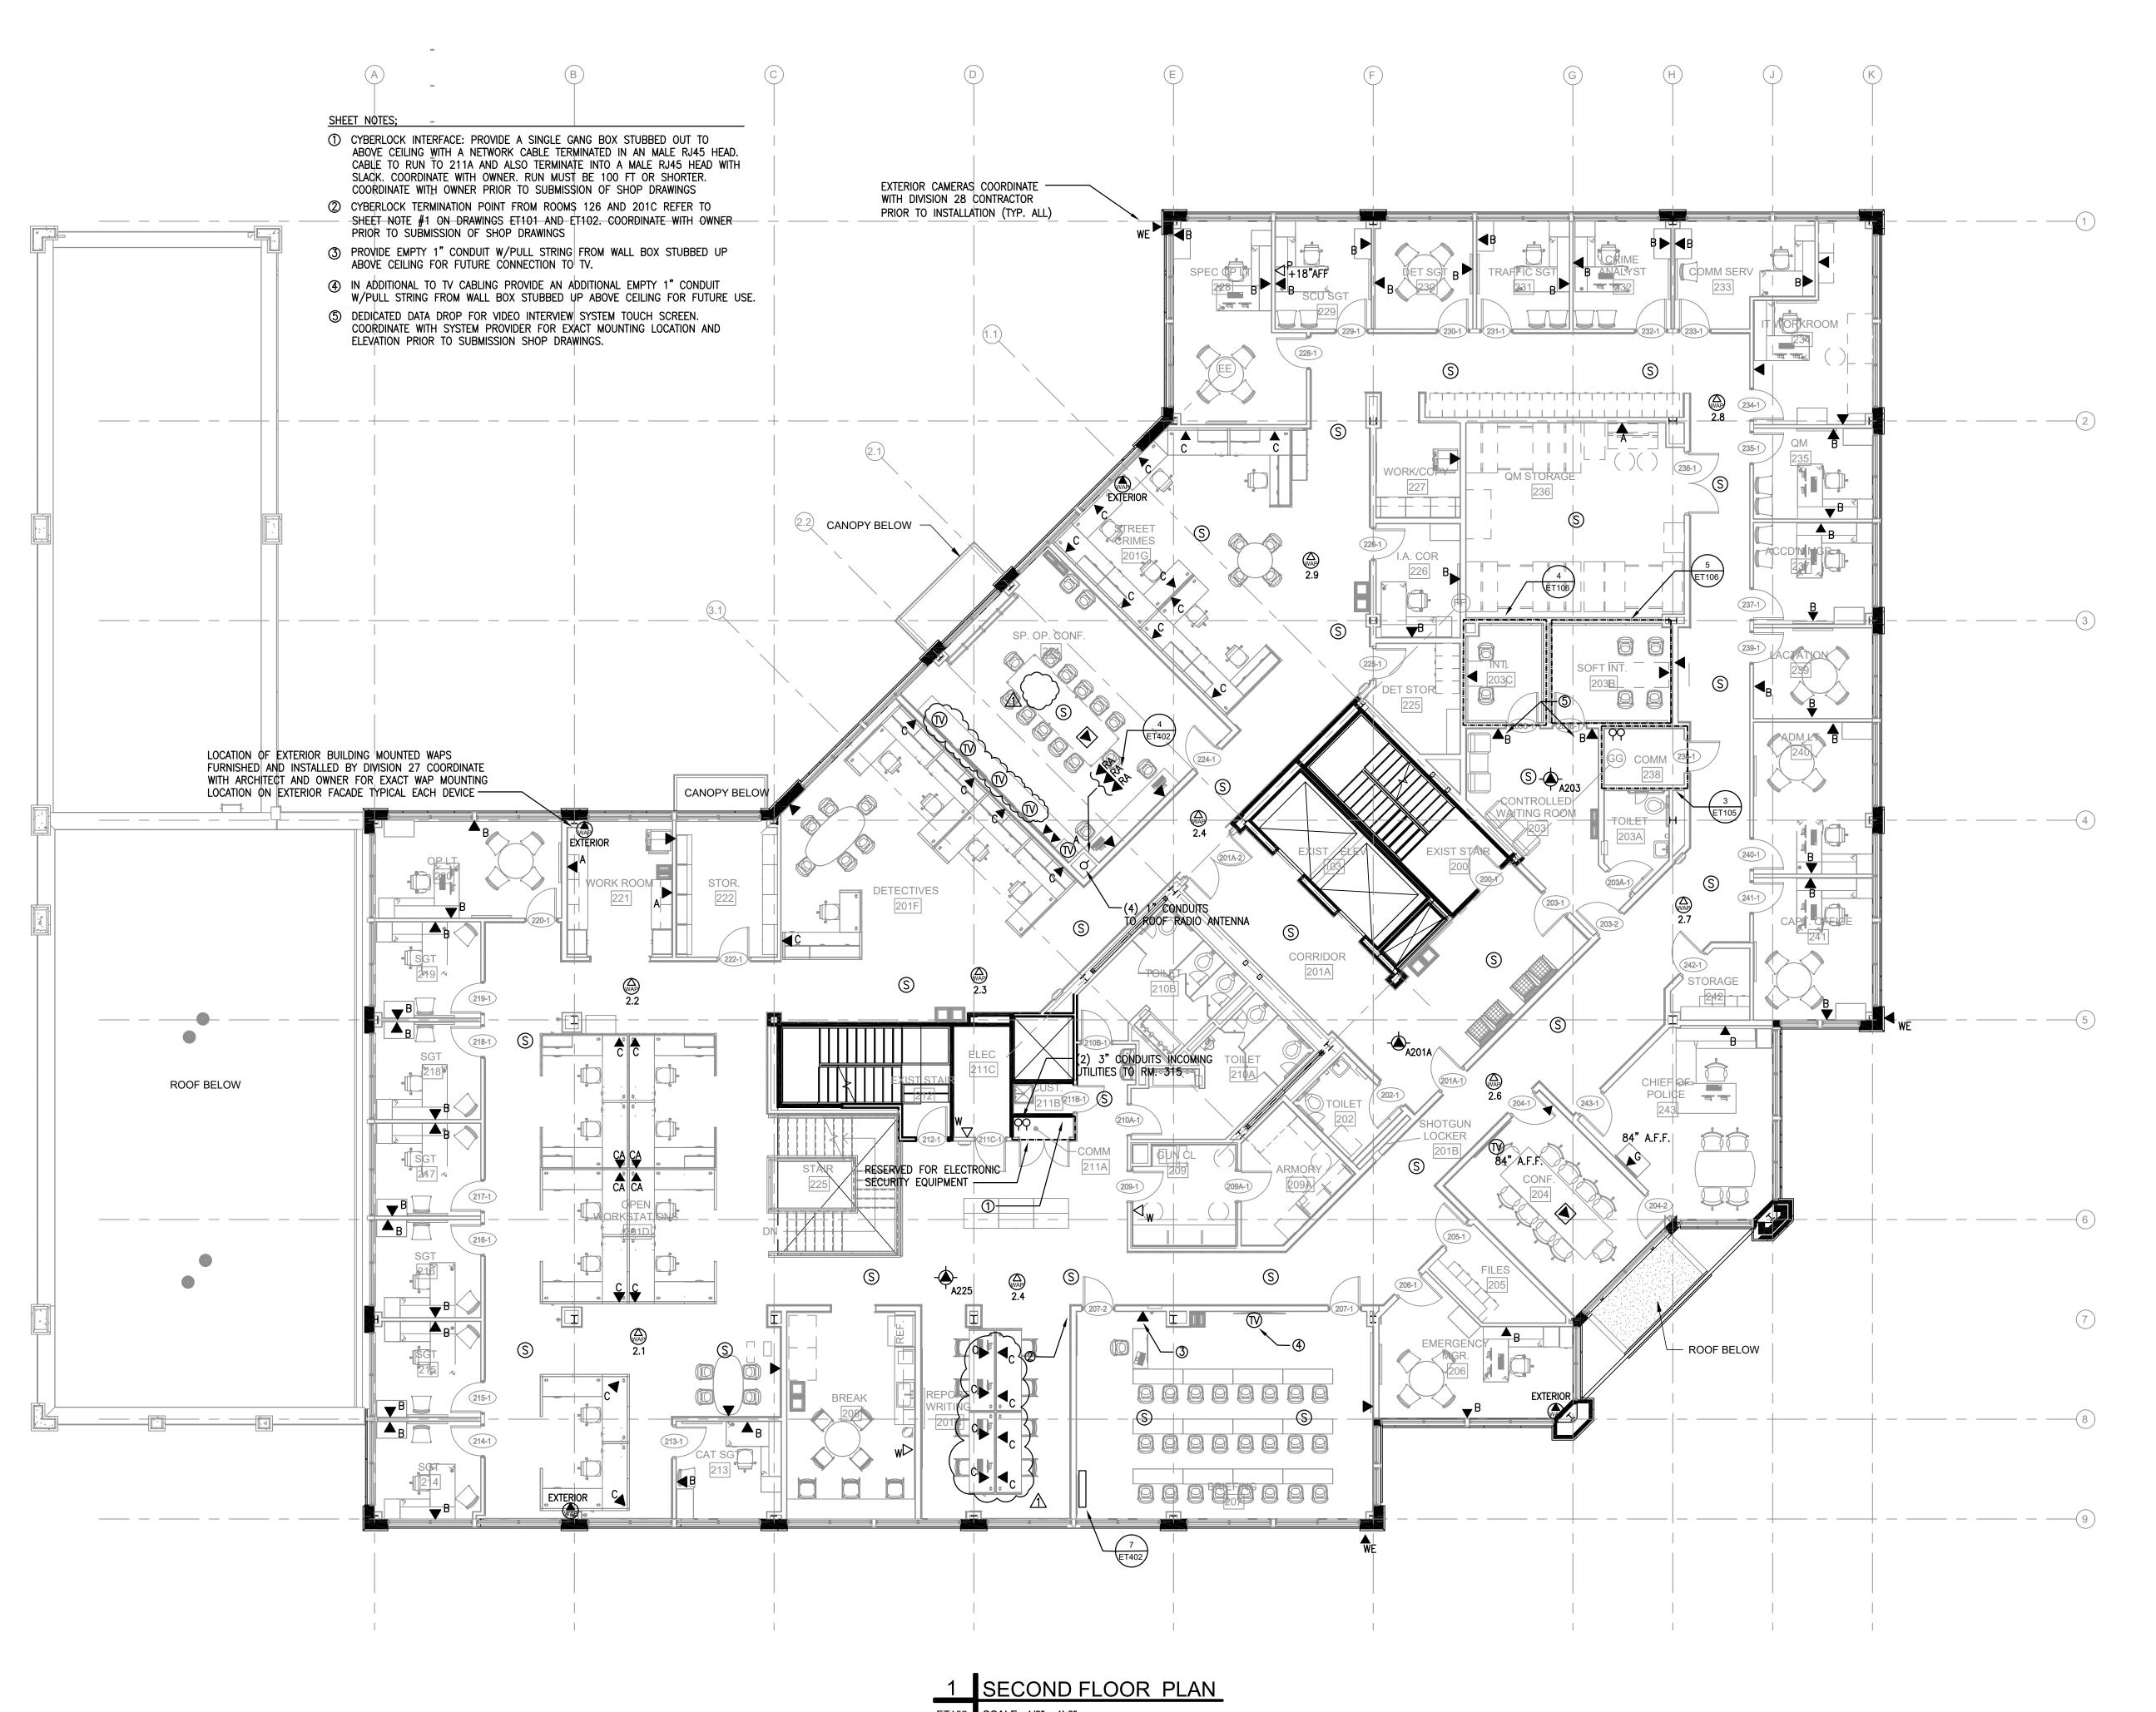

SYMBOL	CONNECTIVITY	NETWORK	CABLE	CABLE	MTG. ELEVATION
$\nabla_{W}$	VOIP PHONE (1)	DATA/TELE	CATEGORY 6	COLOR BLUE	DWG. ET401  DETAIL 1
▼ W	DATA DROPS (2)	DATA/TELE	CATEGORY 6	BLUE	DETAIL 2
<b>V</b> <sub>A</sub>	DATA DROPS (2)	DATA/TELE	CATEGORY 6	BLUE	DETAIL 3
$\mathbf{V}_{B}$	DATA DROP (1)	DATA/TELE	CATEGORY 6	BLUE	DETAIL 4
▼c	DATA DROP (1)	DATA/TELE	CATEGORY 6	BLUE	DETAIL 5
<b>▼</b> CA	DATA DROP (2)	DATA/TELE	CATEGORY 6	BLUE	DETAIL 6
$\mathbf{V}_{D}$	DATA DROPS (4)	DATA/TELE	CATEGORY 6	BLUE	DETAIL 7
▼E	DATA DROPS (4)	VI SYSTEM	CATEGORY 6	RED (	DETAIL 8
<b>▼</b> <sub>F</sub>	DATA DROPS (4)	DATA/TELE	CATEGORY 6	BLUE	DETAIL 9
$lacktriangledown_{\mathbb{G}}$	DATA DROPS (1) TELEVISION (1)	DATA/CATV	CATEGORY 6 COAXIAL	BLUE (	DETAIL 10
$\nabla_{\!P}$	ANALOG PHONE (1)	PHONE	CATEGORY 6	YELLOW (	DETAIL 11
lacksquareRA	ANTENNA DROPS (4)	RADIO	COAXIAL	BLACK	DETAIL 12
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<b>-</b>	CAMERA DROP (1)	SECURITY	CATEGORY 6	WHITE (	DETAIL 21
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WAP	DATA DROP (2)	DATA/TELE	CATEGORY 6	BLUE	DETAIL 23
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\(\lambda\)	CATV (4)	CATV	COAXIAL	BLACK	DETAIL 25

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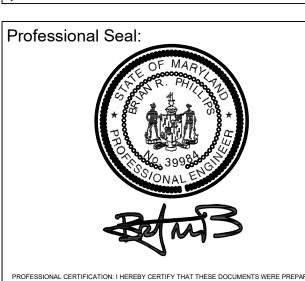
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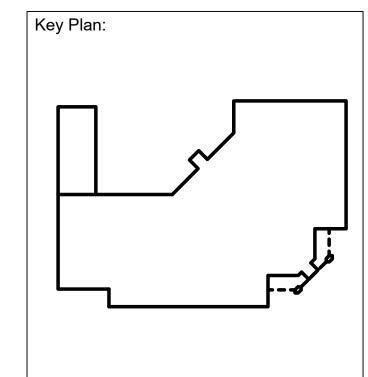
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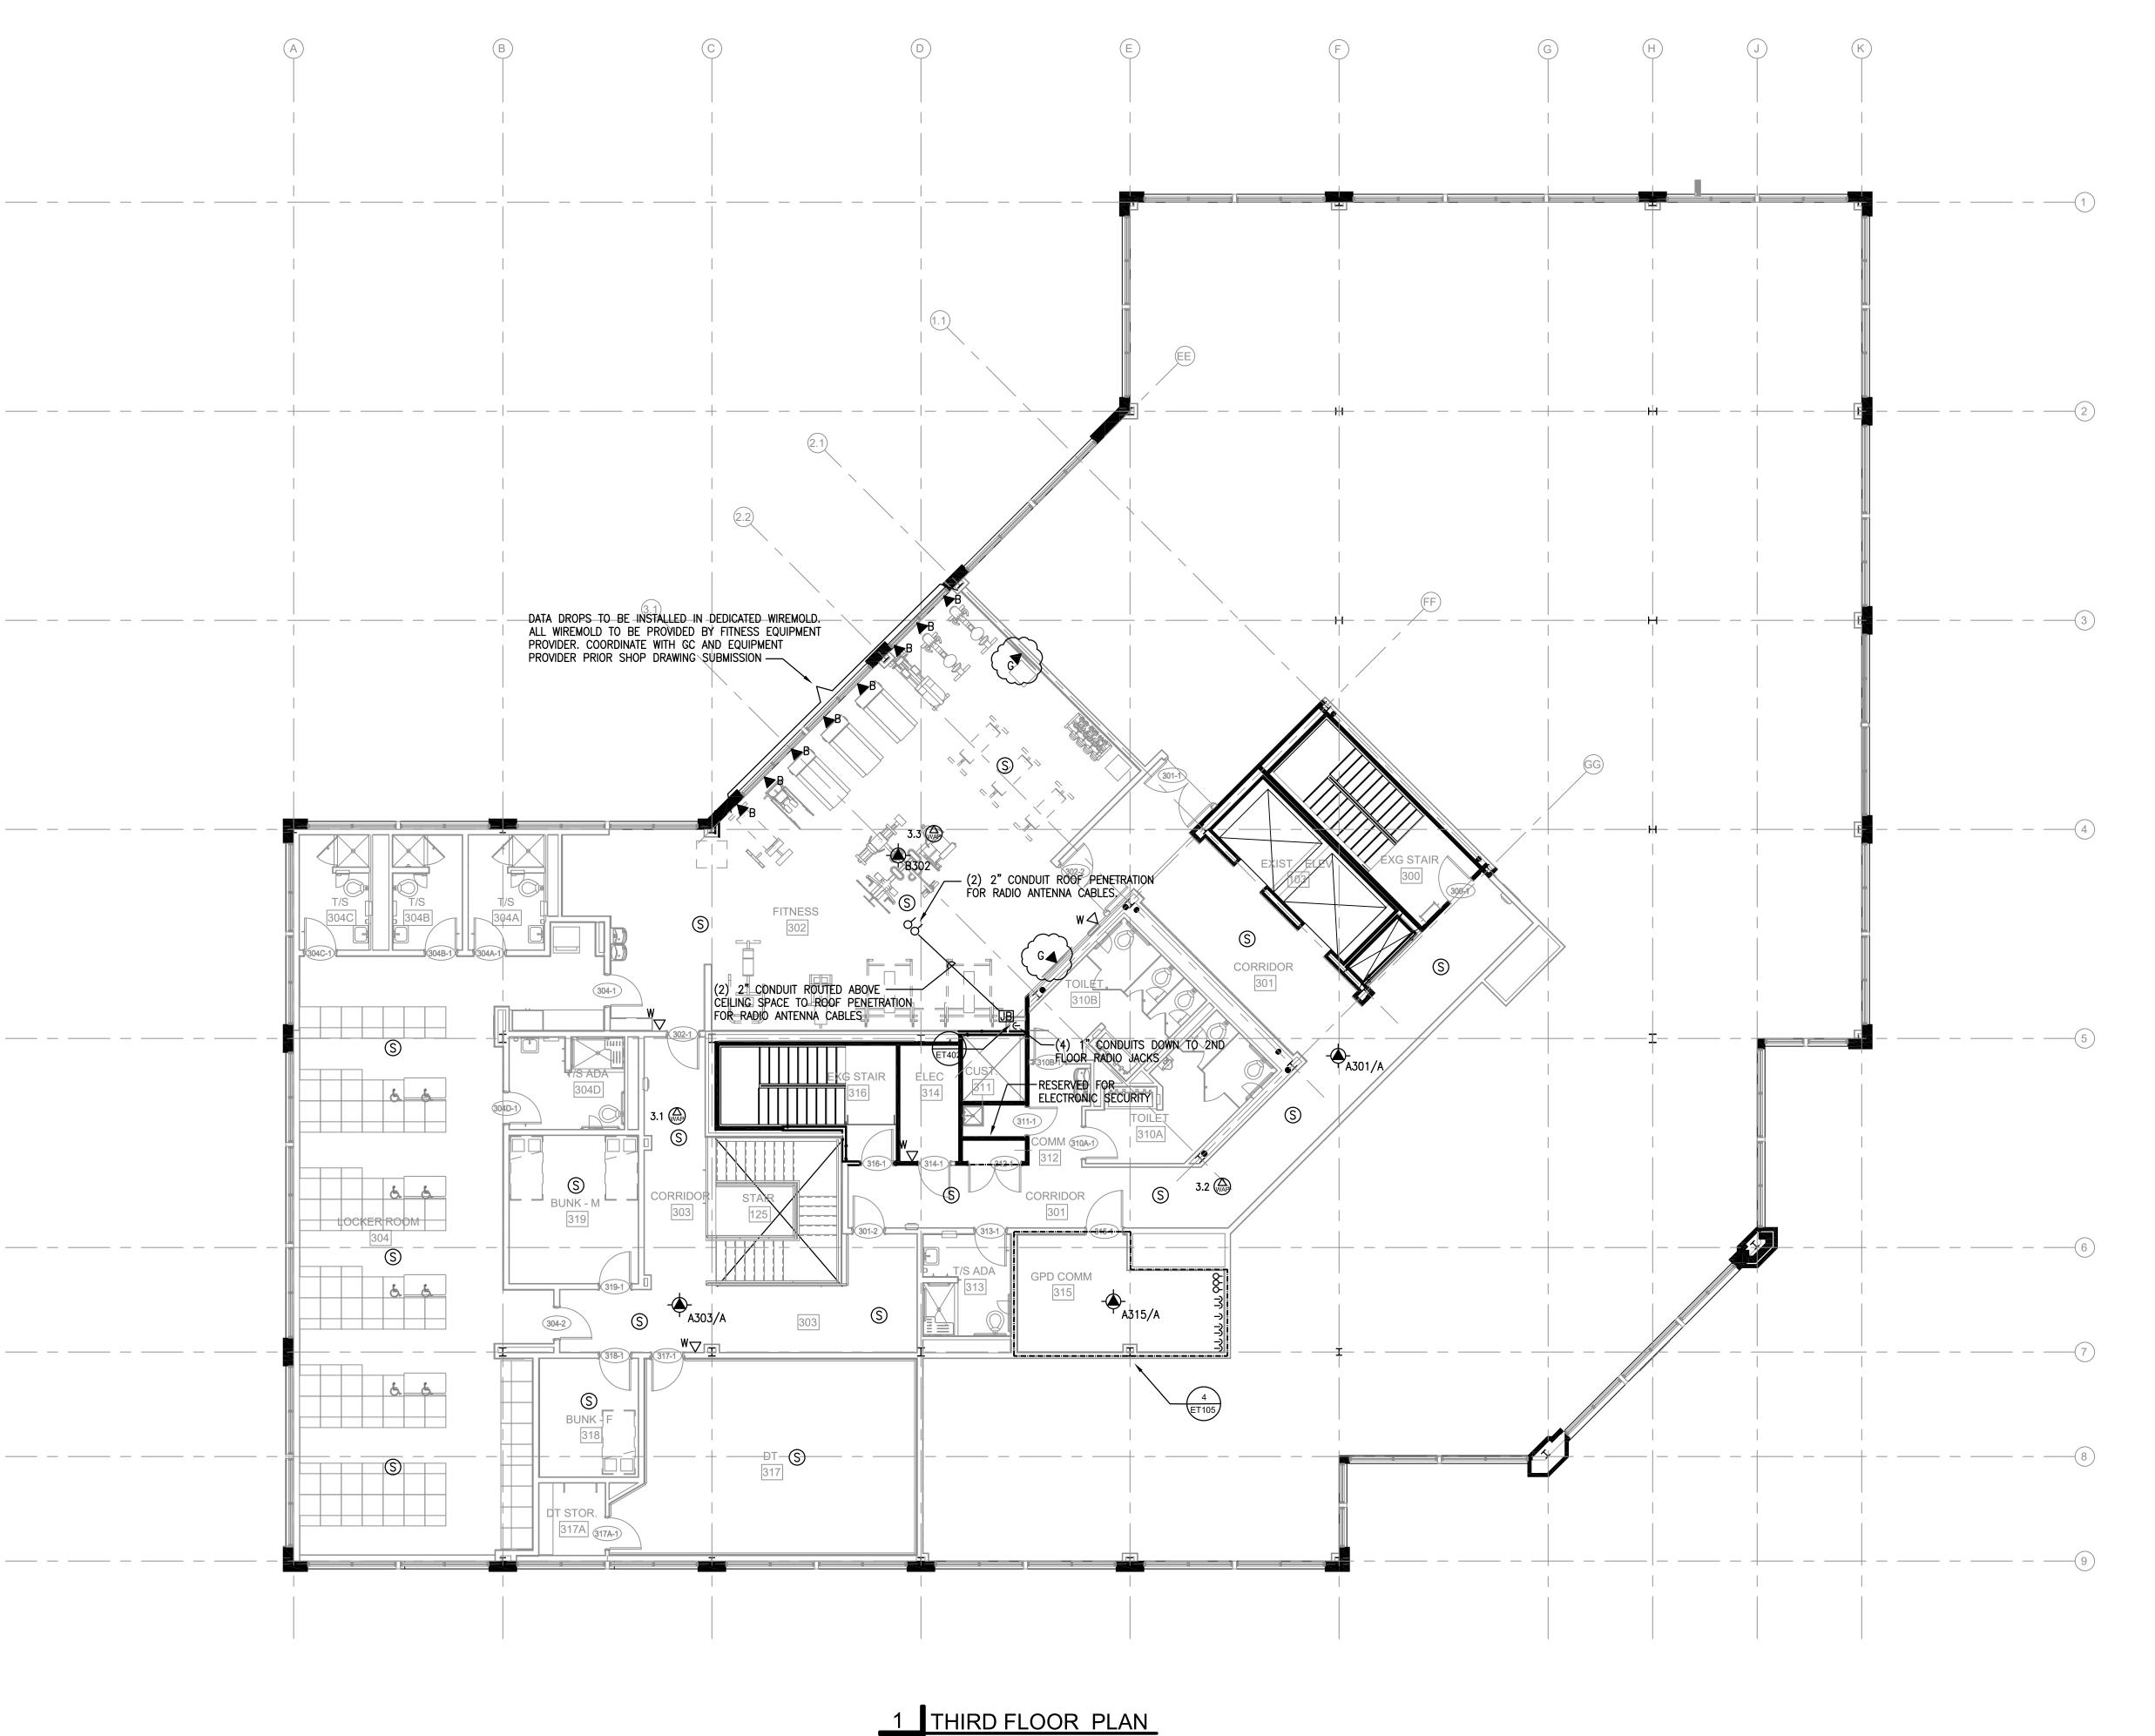


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Drawing Title:

TELECOMMUNICATIONS
SECOND FLOOR
PLAN

Drawing Number:



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$\nabla_{\!\scriptscriptstyle{W}}$	VOIP PHONE (1)	DATA/TELE	CATEGORY 6	BLUE	DETAIL 1
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lacksquareB	DATA DROP (1)	DATA/TELE	CATEGORY 6	BLUE	DETAIL 4
$ ightharpoons_{C}$	DATA DROP (1)	DATA/TELE	CATEGORY 6	BLUE	DETAIL 5
$\mathbf{V}_{CA}$	DATA DROP (2)	DATA/TELE	CATEGORY 6	BLUE	DETAIL 6
$\blacktriangledown_{D}$	DATA DROPS (4)	DATA/TELE	CATEGORY 6	BLUE	DETAIL 7
lacksquareE	DATA DROPS (4)	VI SYSTEM	CATEGORY 6	RED (	DETAIL 8
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lacksquare	DATA DROPS (1) TELEVISION (1)	DATA/CATV	CATEGORY 6 COAXIAL	BLUE BLACK	DETAIL 10
$\nabla_{\!P}$	ANALOG PHONE (1)	PHONE	CATEGORY 6	YELLOW (	DETAIL 11
lacksquareRA	ANTENNA DROPS (4)	RADIO	COAXIAL	BLACK	DETAIL 12
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lacksquare	CAMERA DROP (1)	SECURITY	CATEGORY 6	WHITE	DETAIL 15
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V	DATA DROPS (2) ANALOG PHONE (1)	DATA/TELE PHONE	CATEGORY 6 CATEGORY 6	BLUE YELLOW	DETAIL 20
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( <u>1</u> V)	DATA DROP (2) TELEVISION (1)	DATA /CATV	CATEGORY 6 COAXIAL	BLUE BLACK	DETAIL 24
(TV) A	CATV (4)	CATV	COAXIAL	BLACK\	DETAIL 25

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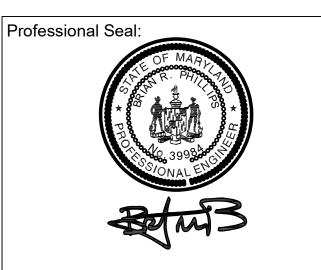
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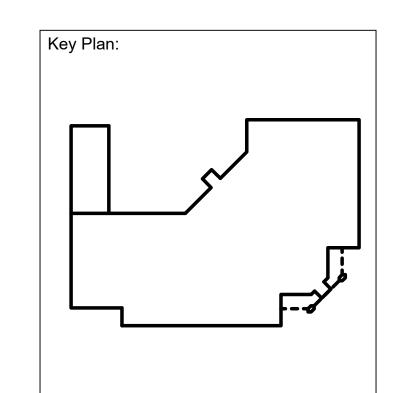
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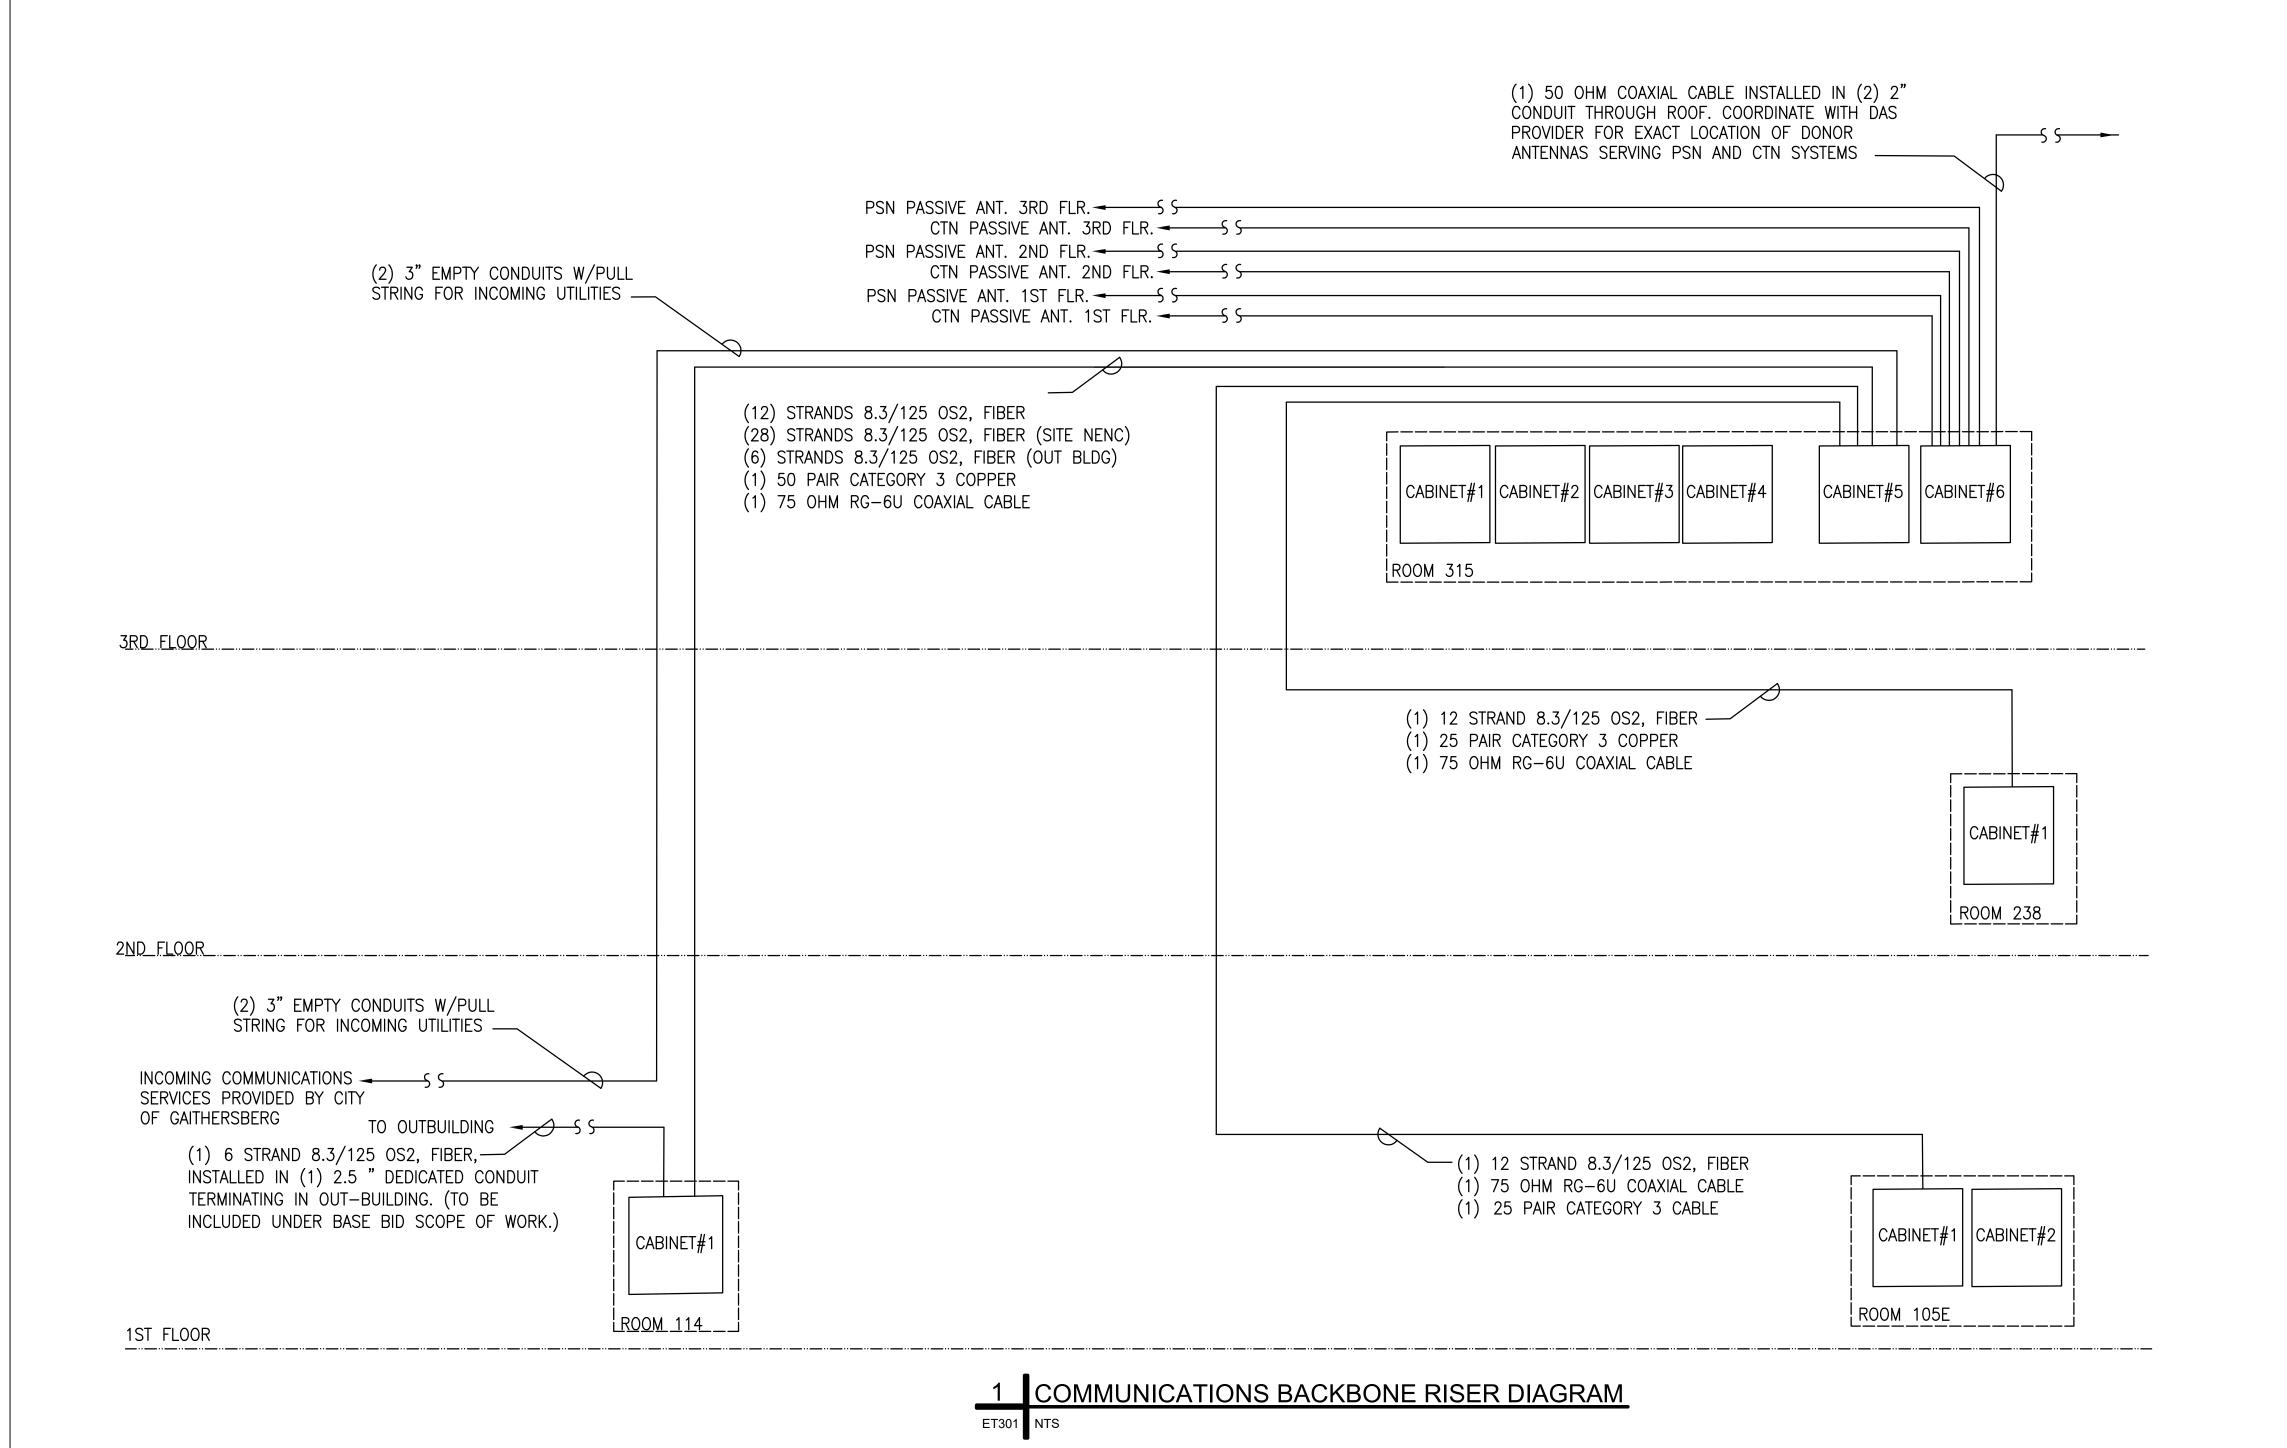



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Drawing Title:

TELECOMMUNICATIONS
THIRD FLOOR
PLAN

Drawing Number:



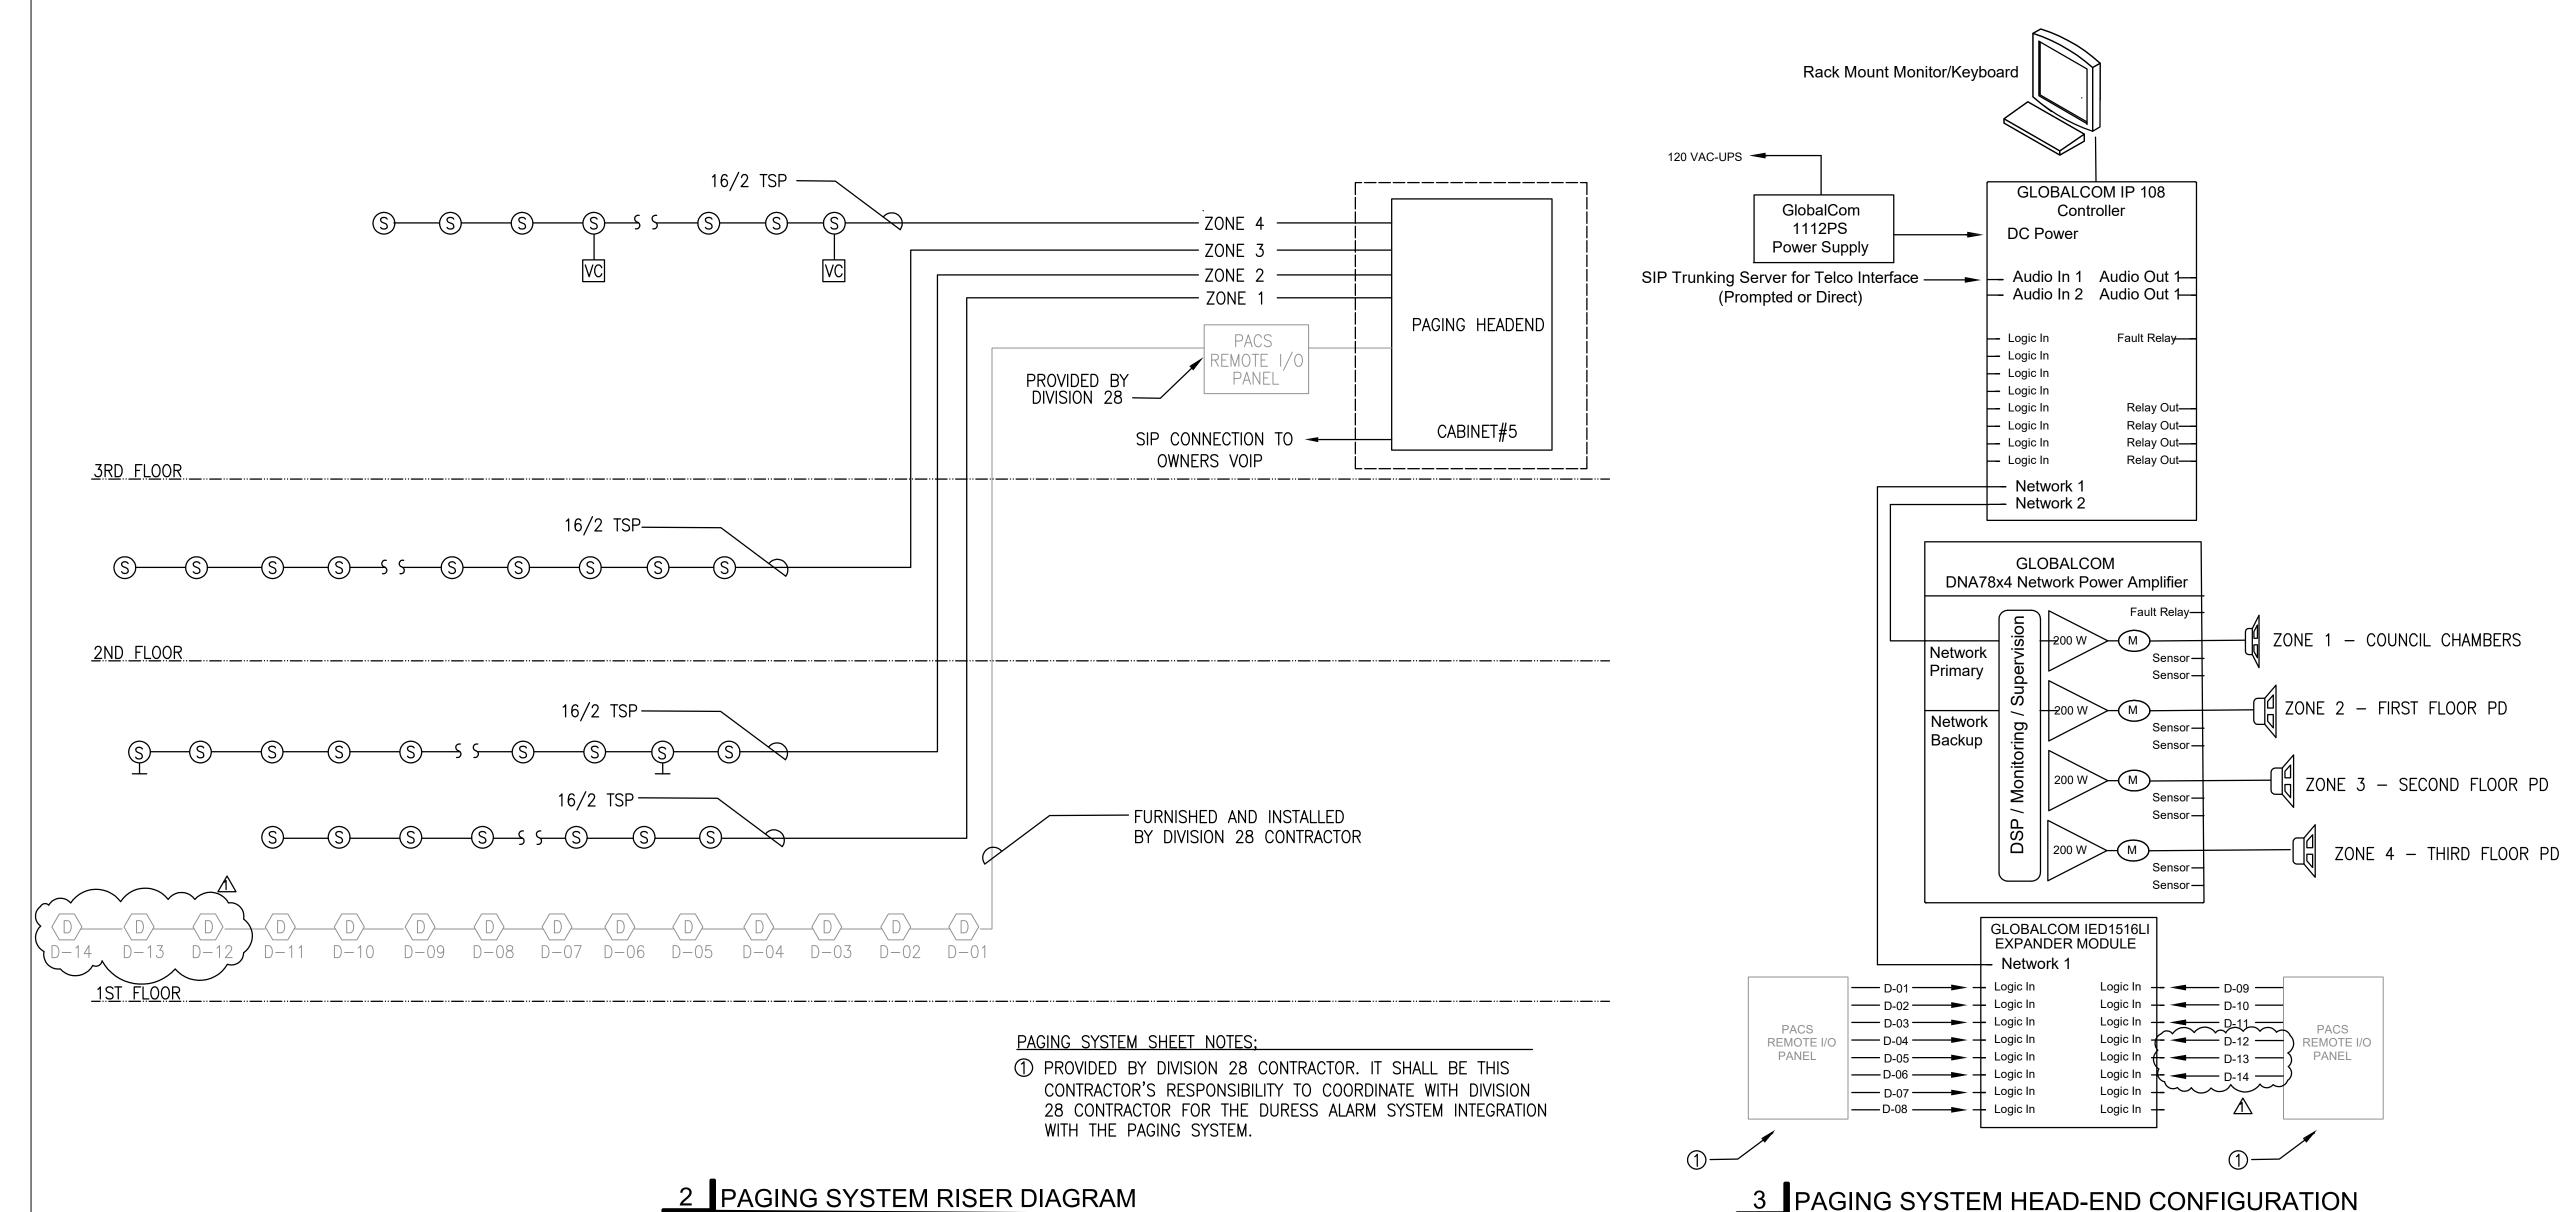

ET301

COMMUNICATIONS RISER DIAGRAM GENERAL NOTES:

- 1. THE COMMUNICATIONS BACKBONE RISER DIAGRAM AS INDICATED IS DIAGRAMMATIC ONLY AND HAS BEEN PROVIDED TO DEMONSTRATE THE GENERAL BACKBONE TOPOLOGY AND CONNECTIVITY NECESSARY FOR THE SUPPORT OF ALL VOICE, DATA, SECURITY AND OWNER COMMUNICATIONS REQUIREMENTS.
- 2. COMMUNICATIONS BACKBONE CABLING BETWEEN THE INCOMING SERVICES AND THE MAIN COMMUNICATIONS ROOM SHALL BE ROUTED THROUGH THE FACILITY INSTALLED IN DEDICATED CONDUITS. ALL COMMUNICATIONS BACKBONE CABLING BETWEEN THE MAIN COMMUNICATIONS ROOM AND REMOTE COMMUNICATIONS ROOMS SHALL BE ROUTED THROUGH THE FACILITY VIA DEDICATED CONDUITS. ALL CABLE PENETRATIONS SHALL BE PROVIDED WITH CONDUIT PIPE CHASES AND PROPERLY FIRE STOPPED.
- 3. ALL BACKBONE CABLING SHALL TERMINATE ON APPROPRIATE CABLE TERMINATION PANELS INSTALLED IN COMMUNICATIONS CABINETS. THE CONTRACTOR SHALL COORDINATE ALL EQUIPMENT INSTALLATIONS, AND CABINET SPACE REQUIREMENTS WITH THE OWNER AND ALL SYSTEM INTEGRATORS. FIBER OPTIC AND COPPER CABLING SHALL BE TESTED AND CERTIFIED IN ACCORDANCE WITH ALL REQUIREMENTS OF THE CONTRACT DOCUMENTS. REFER TO RELATED SPECIFICATIONS SECTIONS FOR ADDITIONAL INFORMATION.
- 4. ALL CABLING AND EQUIPMENT INSTALLATIONS SHALL BE IN ACCORDANCE WITH GOOD ENGINEERING PRACTICES AND BY ALL IEEE, EIA, NEC AND MANUFACTURER'S REQUIREMENTS. ALL CABLING SHALL COMPLY WITH ALL STATE AND LOCAL ELECTRICAL CODES AND SHALL TEST FREE FROM ALL GROUNDS, SHORTS, STRAY VOLTAGES AND EMI.
- 5. PROVIDE ALL EQUIPMENT CLEARANCES IN ACCORDANCE WITH NEC REQUIREMENTS.
  ARRANGE EQUIPMENT TO FACILITATE UNRESTRICTED ACCESS FOR MAINTENANCE AND
  SERVICE AROUND ALL EQUIPMENT, COMPONENTS AND/OR CABLE TERMINATIONS.
- 6. ALL PENETRATIONS OF WALLS AND/OR FLOORS SHALL BE FIRE STOPPED IN ACCORDANCE WITH THE ASTM AND NFPA REQUIREMENTS. REFER TO RELATED SPECIFICATION SECTIONS FOR ADDITIONAL INFORMATION. INSTALLATION OF FIRESTOPS SHALL BE PERFORMED BY AN APPLICATOR/INSTALLER QUALIFIED AND TRAINED BY THE MANUFACTURER. INSTALLATION SHALL BE PERFORMED IN STRICT ACCORDANCE WITH MANUFACTURER'S DETAILED INSTALLATION PROCEDURES.
- 7. WORK SHALL BE NEAT IN APPEARANCE, FREE OF ROUGH EDGES, SCRATCHES, BLEMISHES, CRACKS AND EXPOSED GAPS. ALL EQUIPMENT SHALL BE SECURED TO THE MOUNTING SURFACE, AND FASTENED WITH HARDWARE APPROVED BY THE MANUFACTURER AND CAPABLE OF SUPPORTING THE RATED LOAD. ALL CABLES INSTALLED IN CABLE TRAYS OR WITHIN ENCLOSURES SHALL BE NEATLY ROUTED AND TIE WRAPPED AT INCHES ON CENTER.
- 8. REFER TO SPECIFICATION SECTION 270500 AND ALL DIVISION 26, AND 28, RELATED DRAWINGS AND SPECIFICATION FOR ADDITIONAL INFORMATION RELATED TO INSTALLATION, SUBMITTALS, WARRANTY, SYSTEM INTEGRATIONS AND CLOSE—OUT REQUIREMENTS. REFER TO ALL RELATED SPECIFICATION SECTIONS AND DRAWINGS FOR ADDITIONAL INFORMATION.

#### PAGING SYSTEM RISER DIAGRAM GENERAL NOTES

- THE PAGING SYSTEM RISER DIAGRAM AS INDICATED IS DIAGRAMMATIC ONLY AND HAS BEEN PROVIDED TO DEMONSTRATE THE GENERAL SYSTEM TOPOLOGY AND CONNECTIVITY NECESSARY FOR THE SUPPORT OF ALL BUILDING WIDE PAGING FUNCTIONS.
- 2. THE BASIS OF DESIGN IS THE GLOBALCOM IP108 PLATFORM WITH INTEGRAL DIGITAL MESSAGE GENERATOR APPROVED EQUAL MANUFACTURERS WILL BE ACCEPTABLE PROVIDING FULL COMPLIANCE WITH THE SYSTEM DESIGN. ALL EQUIPMENT AND PERIPHERAL DEVICES SHALL BE THE STANDARD PRODUCT OF A SINGLE MANUFACTURER AND SHALL DISPLAY THE MANUFACTURER'S NAME ON EACH COMPONENT.
- 3. THE CONTRACTOR SHALL INCLUDE ALL EQUIPMENT, MATERIALS, COMPONENTS, SPEAKERS, VOLUME CONTROL CABLING, SOFTWARE, PROGRAMMING AND APPURTENANCES INSTALLED IN ACCORDANCE WITH ALL MANUFACTURERS' RECOMMENDATIONS, AS WELL AS ALL RELATED CONTRACT DOCUMENTS IN ORDER TO ENSURE PROPER INSTALLATION OPERATION AND INTEGRATION OF ALL COMPONENTS, EQUIPMENT, DEVICES AND/OR SYSTEMS.
- 4. THE CONTRACTOR SHALL BE RESPONSIBLE FOR PROVIDING ALL WIRING, CONNECTIONS TO ALL EQUIPMENT, CIRCUITS AND DEVICES AS WELL AS ALL COORDINATION AND PROGRAMMING FOR THE INTEGRATION OF ALL ANCILLARY SYSTEMS IMPACTING THE OPERATION OF THE PAGING SYSTEM. COORDINATE WITH OWNER PRIOR TO PROGRAMMING ALL CUSTOM MESSAGES AND SPEAKER ZONE ACTIVIATIONS.
- 5. WHERE MANUFACTURER AND/OR MODEL NUMBERS REFERENCE SPECIFIC SYSTEM COMPONENTS IN THIS SPECIFICATION, IT IS TO ESTABLISH THE PERFORMANCE REQUIREMENTS AND QUALITY OF THE SYSTEMS AND COMPONENTS ONLY (APPROVED EQUAL SHALL BE ACCEPTABLE PROVIDING THE SYSTEM MEETS THE PERFORMANCE CAPABILITES OF THE GLOBALCOM SYSTEMS). THE SYSTEM HEADEND SHALL CONSIST AT THE MINIMUM THE FOLLOWING COMPONENTS;
- 1 IP108 GLOBALCOM IP100 CONTROLLER WITH ADDITIONAL 8X8 COBRANET AUDIO CHANNELS AND DIGITAL MULTI-CHANNEL MESSAGE GENERATOR
- 1 IED1112PS GLOBALCOM RACK POWER SUPPLY SYSTEM W/ONE MODULAR SUPPLY 1 ATLAS—IED COMPUTER KEYBOARD DRAWER ASSEMBLY W/LCD SCREEN SUPPLY
- 1 DNA2404CL GLOBALCOM 1000 SERIES 4X600 WATT DIGITAL NETWORK AUDIO POWER AMPLIFIER (120AC/70V CONSTANT VOLTAGE)
- 1 LOT SOFTWARE, LICENSES AND PROGRAMMING
- 6. THE CEILING SPEAKER ASSEMBLIES SHALL BE ATLAS SOUND NO. 193-8 OR APPROVED EQUAL. IT SHALL CONSIST OF AN 8-INCH 5 OZ. MAGNET SPEAKER COMPLETE WITH 70V LINE MATCHING TRANSFORMER WITH MULTIPLE TAP SETTINGS AND ASSEMBLED TO A BAFFLE (MODEL NO. ACC1000). THE CIRCULAR BAFFLE SHALL BE 12-3/4" IN DIAMETER AND 3/8" DEEP. IT SHALL BE CONSTRUCTED OF 22 GAUGE, COLD-ROLLED STEEL (ZINCROMETAL), WITH A BAKED ON SEMI-GLOSS EPOXY FINISH, WHICH SHALL BE MAR-PROOF. COORDINATE INSTALLATION WITH ALL REFLECTED CEILING PLANS.
- 7. EACH SPEAKER UNIT SHALL BE SUPPLIED WITH INTEGRAL COMPRESSION DRIVER WITH DOUBLE RE-ENTRANT ACOUSTIC PATH AND EXPONENTIALLY FLARED SQUARE BELL. UNIT SHALL HAVE AN AUDIO POWER RATING OF 15 WATTS. FREQUENCY RESPONSE RANGE SHALL BE 400-14,000 HZ (NOMINAL), 500-6,000 HZ (+5DB). SOUND PRESSURE LEVEL SHALL BE 116 DB AT 15 WATTS/1METER, 106 DB AT 1 WATT/1METER. SOUND DISPERSION SHALL BE 70 DEGREES (-6 DB AT 2000 HZ OCTAVE BAND).
- 8. ALL CEILING MOUNTED CORRIDOR SPEAKER LOCATIONS SHALL BE TAPPED AT A MINIMUM OF 1 WATT, ALL CEILING MOUNTED OFFICE SPEAKERS SHALL BE TAPPED AT .5 WATTS ALL HORN TYPE AND EXTERIOR SPEAKERS SHALL BE TAPPED AT A MINIMUM OF 15 WATTS.
- 9. THE SYSTEM SHALL INCLUDE THE CAPABILITY FOR THE INSTANTANEOUS DISTRIBUTION OF ANNOUNCEMENTS SIMULTANEOUSLY, THROUGH THE INTEGRATION OF THE TELEPHONE SYSTEM TO ALL LOCATIONS EQUIPPED WITH SPEAKERS. ALL EMERGENCY ANNOUNCEMENTS ORIGINATING FROM ANY DURESS BUTTON SHALL HAVE PRIORITY OVER ALL REGULAR SYSTEM FUNCTIONS.
- 10. ALL CABLING AND EQUIPMENT INSTALLATIONS SHALL BE IN ACCORDANCE WITH GOOD ENGINEERING PRACTICES AND BY ALL IEEE, EIA, NEC AND ALL MANUFACTURER'S REQUIREMENTS. ALL CABLING SHALL COMPLY WITH ALL STATE AND LOCAL ELECTRICAL CODES AND SHALL TEST FREE FROM ALL GROUNDS, SHORTS, STRAY VOLTAGES AND EMI.
- 11. PROVIDE ALL EQUIPMENT CLEARANCES IN ACCORDANCE WITH NEC REQUIREMENTS. ARRANGE EQUIPMENT TO FACILITATE UNRESTRICTED ACCESS FOR MAINTENANCE AND SERVICE AROUND ALL EQUIPMENT, COMPONENTS AND/OR CABLE TERMINATIONS.
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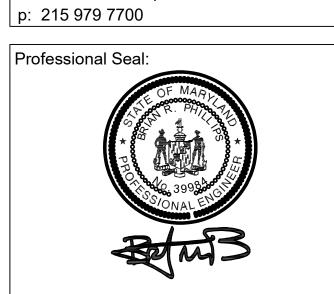
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Additions and Renovations to:

CITY OF GAITHERSBURG

16 S. SUMMIT AVE.

GAITHERSBURG, MD


FOR: CITY OF GAITHERSBURG

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SGA PROJECT NUMBER: 17-002

Drawn By: AJF Checked By: AJF

Key Plan:

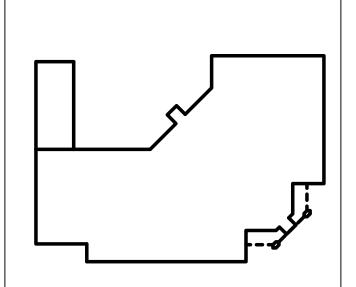

Drawn By: AJF Checked By: AJF


COMMUNICATIONS RISER DIAGRAMS

Drawing Number:

**Drawing Title:** 





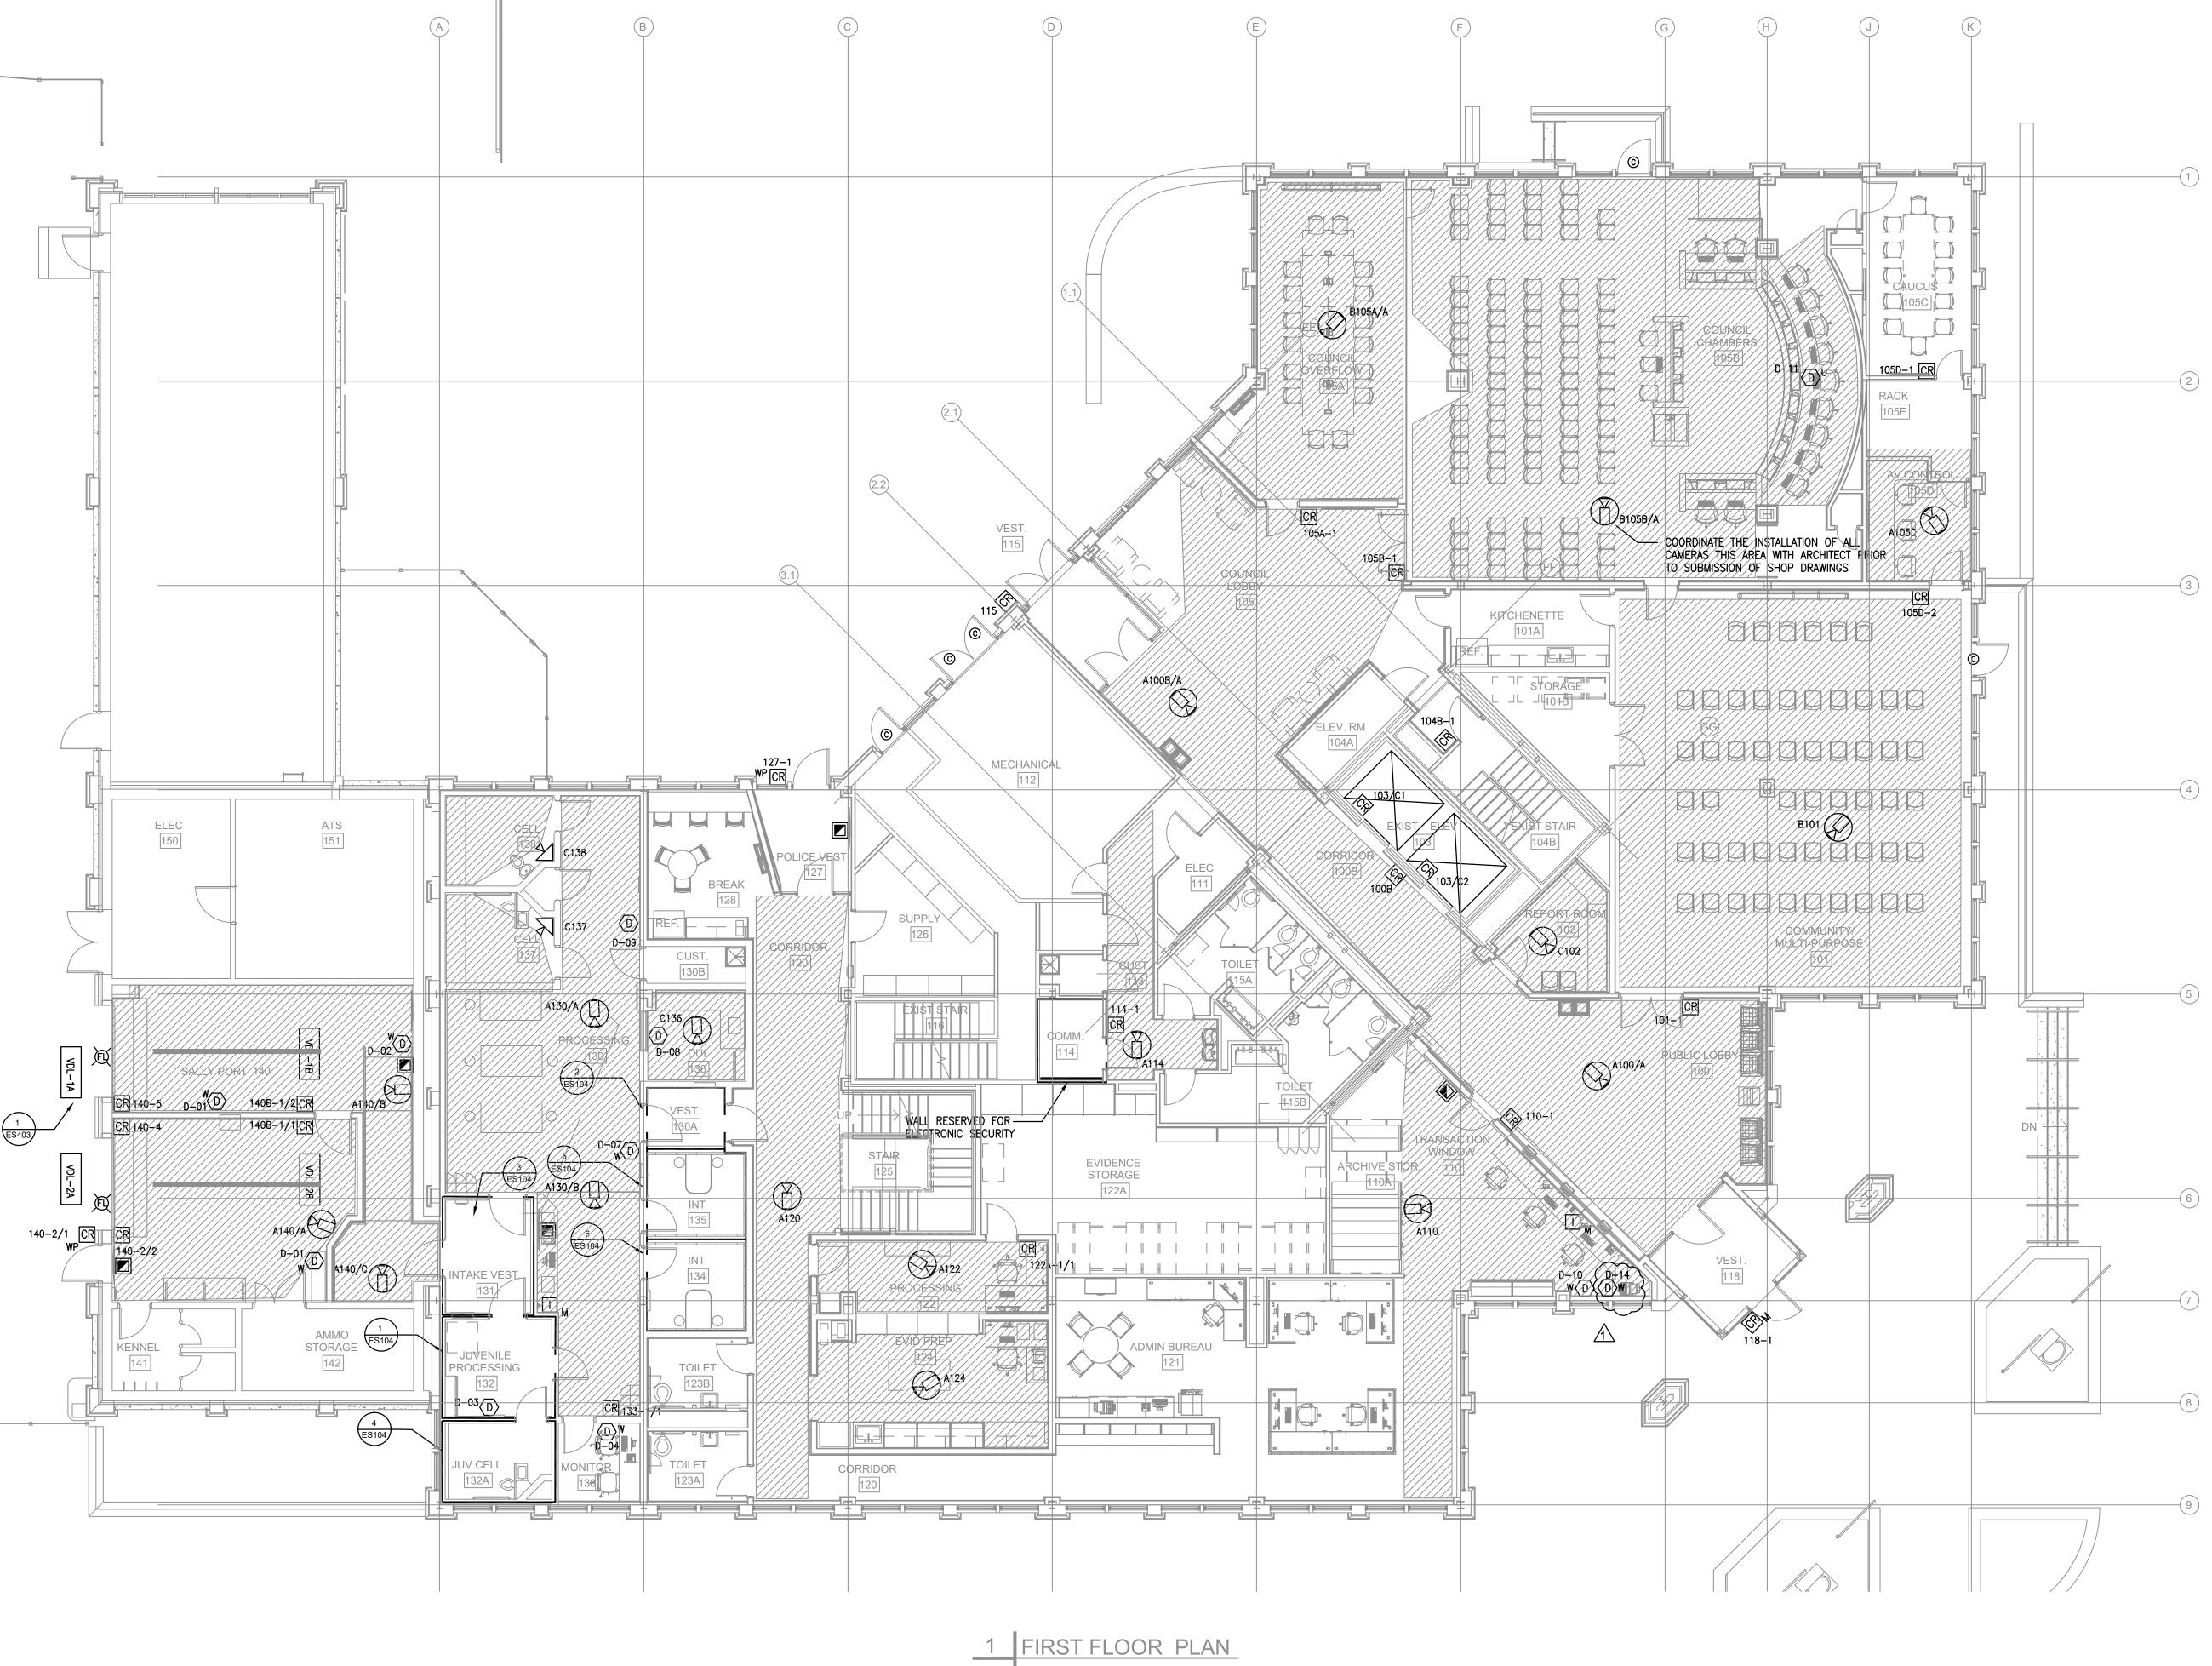

1 FIRST FLOOR PLAN
ES101 SCALE: 1/8" = 1'-0"

## SCHRADERGROUP Architecture, LLC

Architecture | Planning | Programming 20 South Charles Street Suite 319 Baltimore, MD 21201 p: 410 235 5851 f: 215 482 7441

Consultants: MK Consulting Engineers 3300 Clipper Mill Road, Suite 201 Baltimore, MD 21211

p: 667 309 6193


www.sgarc.com

Burdette, Koehler, Murphy & Associates, Inc.

6300 Blair Hill Lane, Suite 400 Baltimore, MD 21209 p: 410 323 0600

Structural Engineer Schrader Group Architecture, LLC 153 East King Street, Suite 211-212 Lancaster, PA 17602 p: 717 299 8965

Data, Telecommunications and Security Burns Engineering, Inc. Two Commerce Square, 2001 Market St. Suite 600 Philadelphia, PA 19103

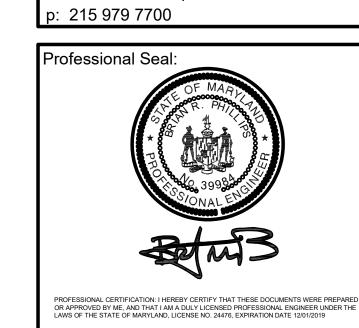


City of Gaithersburg, MD

31 South Summit Avenue Gaithersburg, MD 20877

CITY OF GAITHERSBURG 16 S. SUMMIT AVE.

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DATE:	1111.	<b>/</b> 16, 2019

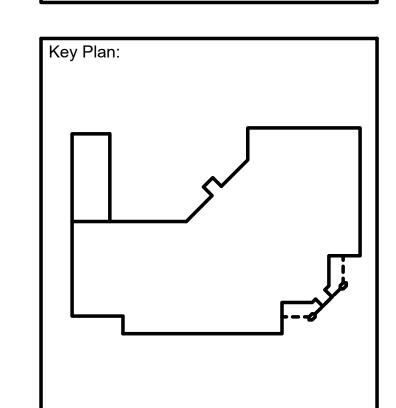

Checked By: AJF Drawn By: AJF

Drawing Title:

SECURITY SYSTEMS FIRST FLOOR PLAN

Drawing Number:







1 SECOND FLOOR PLAN
ES102 SCALE: 1/8" = 1'-0"

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Architecture | Planning | Programming 20 South Charles Street Suite 319 Baltimore, MD 21201 p: 410 235 5851 f: 215 482 7441

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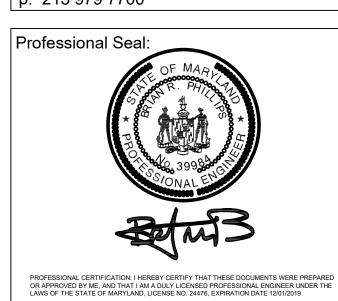
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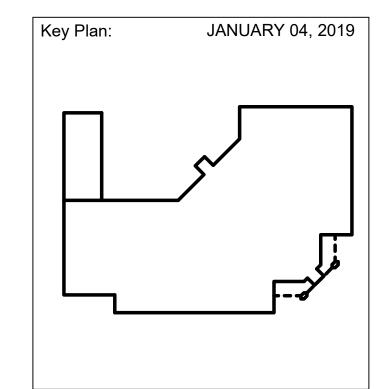


City of Gaithersburg, MD

31 South Summit Avenue Gaithersburg, MD 20877

CITY OF GAITHERSBURG 16 S. SUMMIT AVE.

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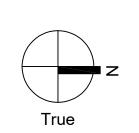



Drawn By: AJF Checked By: AJF

Drawing Title:

SECURITY SYSTEMS SECOND FLOOR PLAN

Drawing Number:



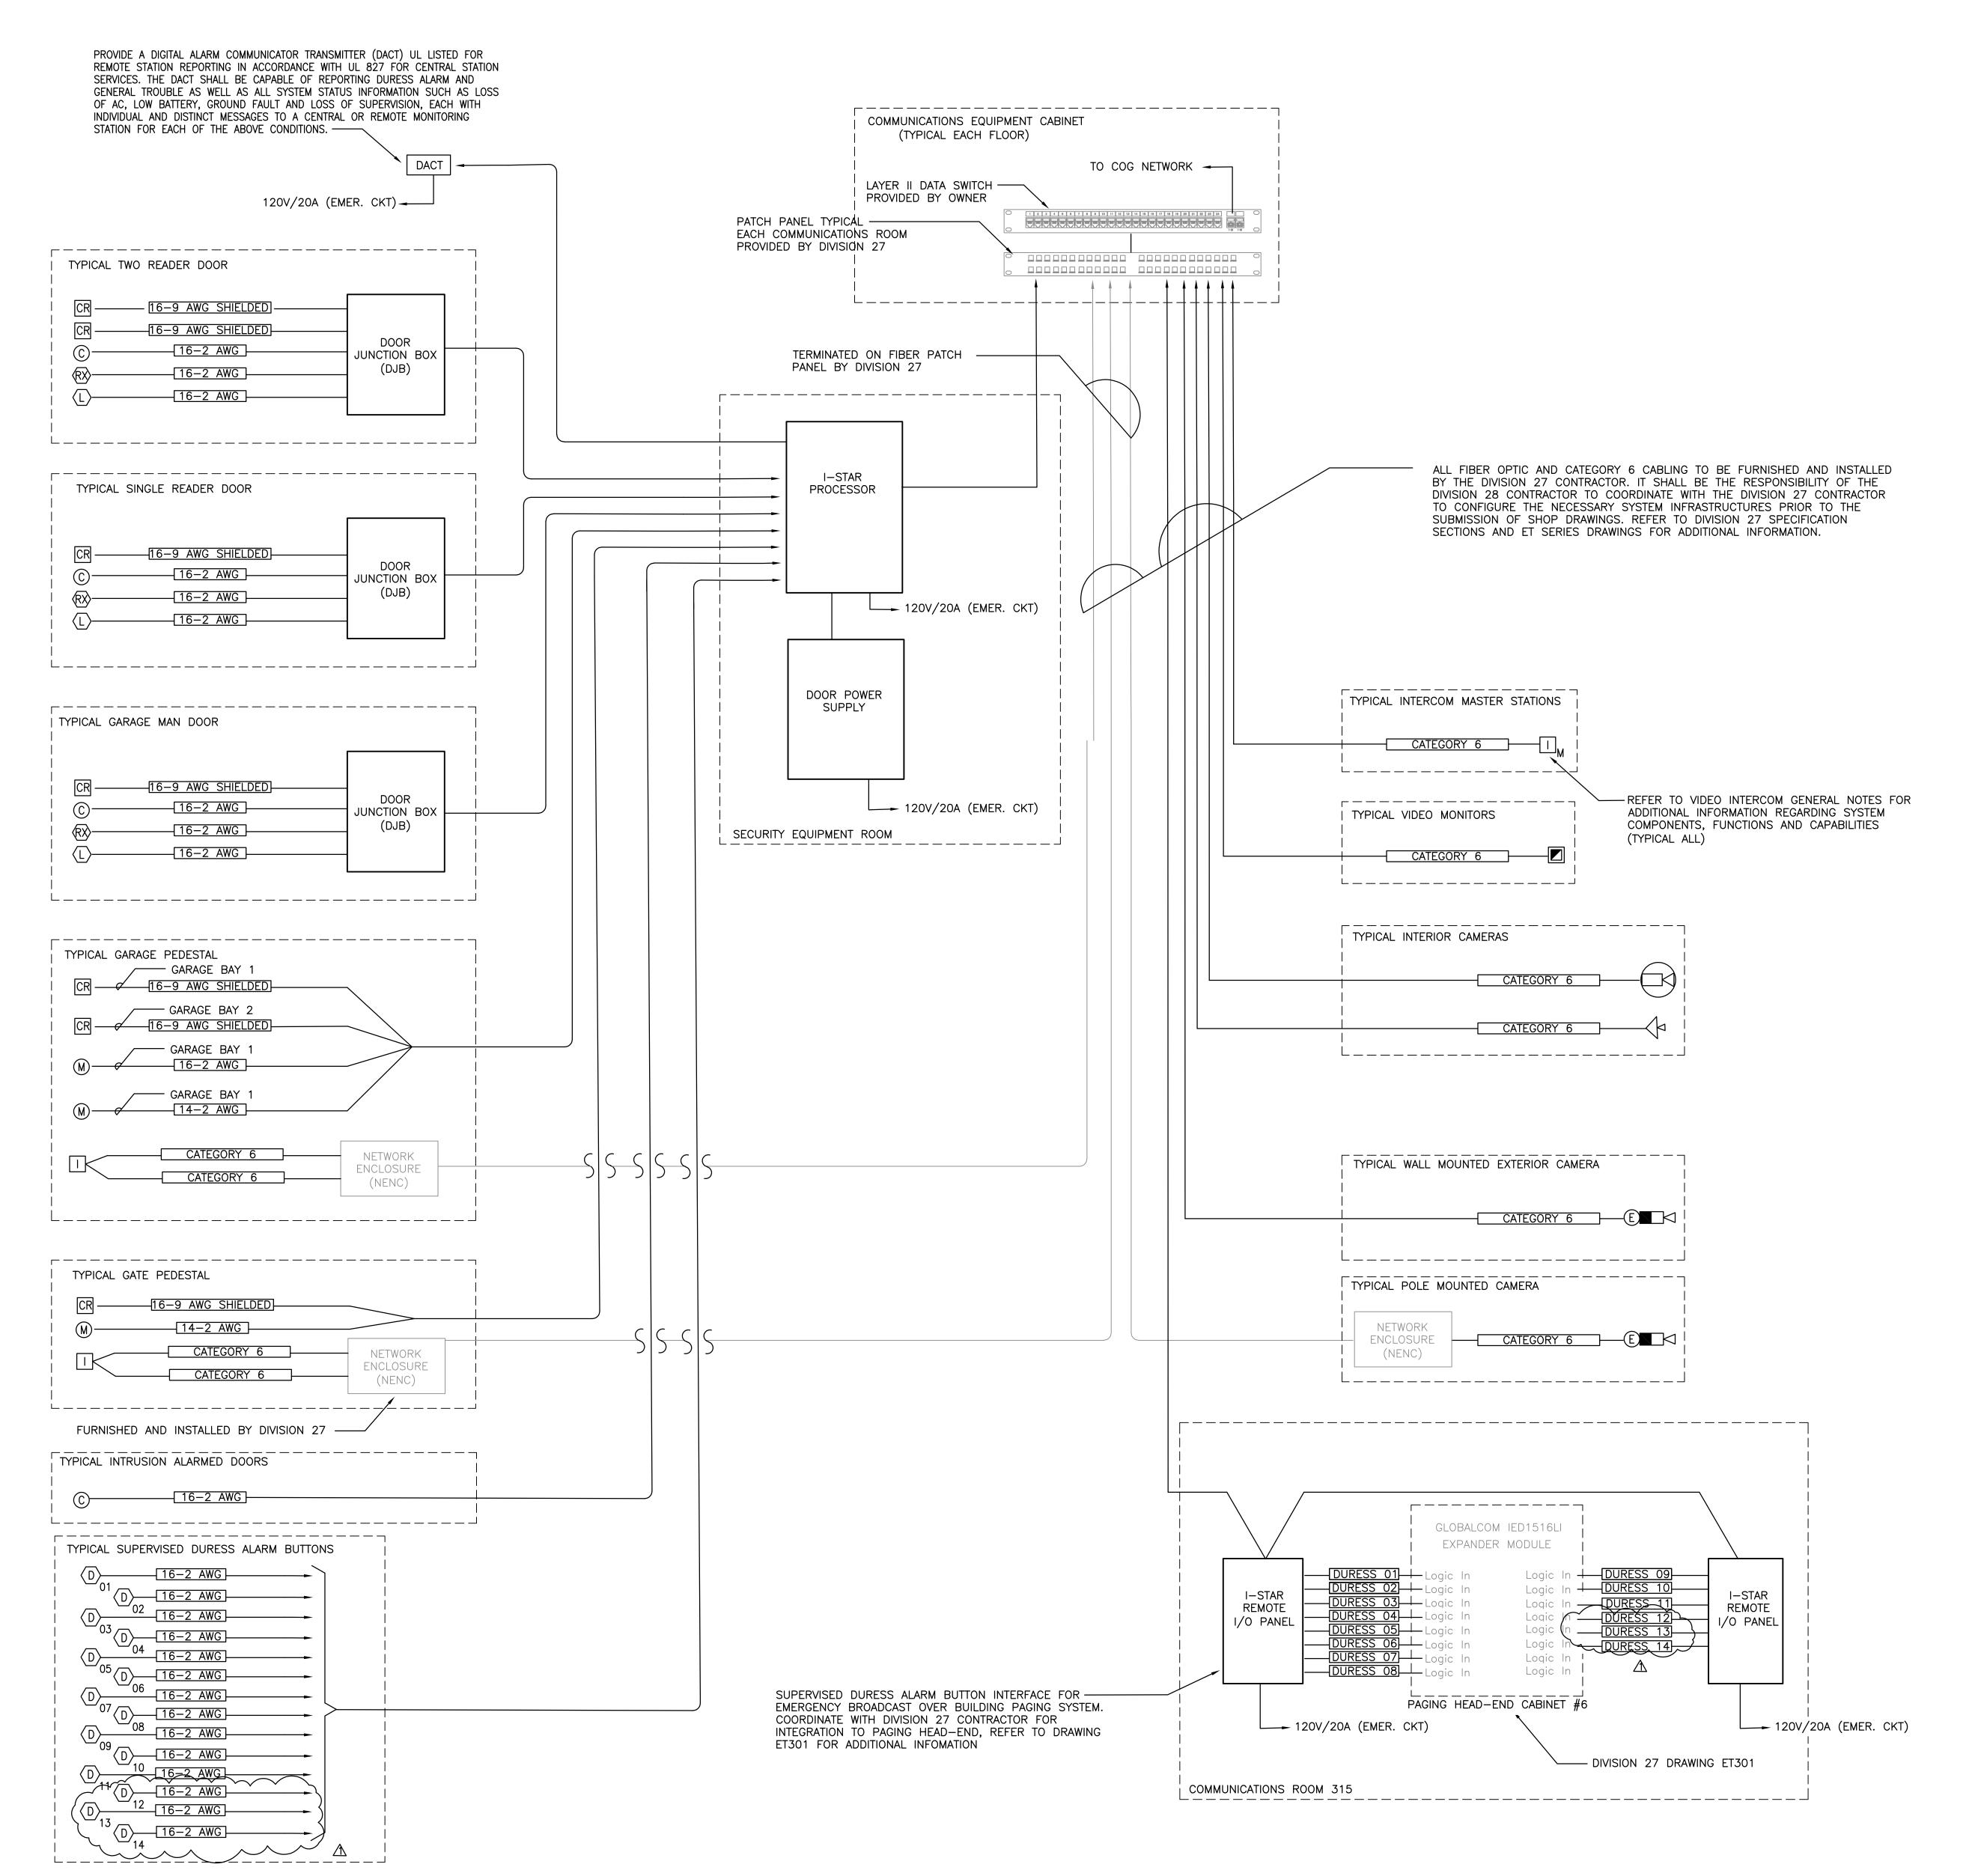

SECURITY SYSTEM GENERAL NOTES;

- SECURITY RISER DIAGRAM IS DIAGRAMMATIC ONLY. REFER TO FLOOR AND SITE PLANS FOR EXACT LOCATION, QUANTITY AND TYPE OF ALL SECURITY DEVICES. ALL CONTROL, ANNUNCIATION, AND MONITOR REQUIREMENTS SHALL BE PROVIDED AS AS REQUIRED TO PERFORM ALL FUNCTIONS AS SPECIFIED AND/OR REQUIRED BY CODE.
- 2. REFER TO SPECIFICATION SECTION 271300 FOR ADDITIONAAL INFORMATION.ALL BACKBONE CABLING SHALL TERMINATE ON APPROPRIATE CABLE TERMINATION PANELS INSTALLED IN COMMUNICATIONS CABINETS. THE CONTRACTOR SHALL COORDINATE ALL EQUIPMENT INSTALLATIONS, AND CABINET SPACE REQUIREMENTS WITH THE OWNER AND ALL SYSTEM INTEGRATORS. FIBER OPTIC AND COPPER CABLING SHALL BE TESTED AND CERTIFIED IN ACCORDANCE WITH ALL REQUIREMENTS OF THE CONTRACT DOCUMENTS. REFER TO RELATED SPECIFICATIONS SECTIONS FOR ADDITIONAL INFORMATION.
- 3. ALL CABLING AND EQUIPMENT INSTALLATIONS SHALL BE IN ACCORDANCE WITH GOOD ENGINEERING PRACTICES AND BY ALL IEEE, EIA, NEC AND MANUFACTURER'S REQUIREMENTS. ALL CABLING SHALL COMPLY WITH ALL STATE AND LOCAL ELECTRICAL CODES AND SHALL TEST FREE FROM ALL GROUNDS, SHORTS, STRAY VOLTAGES AND EMI.
- 4. PROVIDE ALL EQUIPMENT CLEARANCES IN ACCORDANCE WITH NEC REQUIREMENTS. ARRANGE EQUIPMENT TO FACILITATE UNRESTRICTED ACCESS FOR MAINTENANCE AND SERVICE AROUND ALL EQUIPMENT. COMPONENTS AND/OR CABLE TERMINATIONS.
- 5. ALL PENETRATIONS OF WALLS AND/OR FLOORS SHALL BE FIRE STOPPED IN ACCORDANCE WITH THE ASTM AND NFPA REQUIREMENTS. REFER TO RELATED SPECIFICATION SECTIONS FOR ADDITIONAL INFORMATION. INSTALLATION OF FIRESTOPS SHALL BE PERFORMED BY AN APPLICATOR/INSTALLER QUALIFIED AND TRAINED BY THE MANUFACTURER. INSTALLATION SHALL BE PERFORMED IN STRICT ACCORDANCE WITH MANUFACTURER'S DETAILED INSTALLATION PROCEDURES.
- 6. WORK SHALL BE NEAT IN APPEARANCE, FREE OF ROUGH EDGES, SCRATCHES, BLEMISHES, CRACKS AND EXPOSED GAPS. ALL EQUIPMENT SHALL BE SECURED TO THE MOUNTING SURFACE, AND FASTENED WITH HARDWARE APPROVED BY THE MANUFACTURER AND CAPABLE OF SUPPORTING THE RATED LOAD. ALL CABLES INSTALLED IN CABLE TRAYS OR WITHIN ENCLOSURES SHALL BE NEATLY ROUTED AND TIE WRAPPED AT 6 INCHES ON CENTER.
- 8. REFER TO ALL DIVISION 26, 27, 28, RELATED DRAWINGS AND SPECIFICATION SECTIONS RELATED TO ALL SYSTEM INSTALLATIONS AND INTEGRATIONS, SUBMITTALS, WARRANTY AND CLOSE—OUT REQUIREMENTS. REFER TO ALL RELATED SPECIFICATION SECTIONS AND DRAWINGS FOR ADDITIONAL INFORMATION.

INTERCOM SYSTEM GENERAL NOTES;

- 1. THE CONTRACTOR SHALL PROVIDE A TCP/IP NETWORK BASED MICROPROCESSOR CONTROLLED VIDEO INTERCOM SYSTEM WITH FULL OPERATIONAL INTEGRATION WITH THE PHYSICAL ACCESS CONTROL AND THE BUILDING VOIP TELEPHONE SYSTEM. THE CONTRACTOR SHALL INCLUDE ALL COMPONENTS, MASTER INTERCOM EXCHANGES, REMOTE INTERCOM STATIONS, ELECTRICAL POWER, PROGRAMMING, AND ALL APPURTENANCES AS NECESSARY TO PROVIDE A FULLY OPERATIONAL INTEGRATED SYSTEM IN ACCORDANCE WITH THE CONTRACT DOCUMENTS.
  - 1.1 ALL TCP/IP-BASED SYSTEMS CABLING SHALL BE FURNISHED AND INSTALLED BY THE DIVISION 27 CONTRACTOR IN ACCORDANCE WITH THE REQUIREMENTS OF RELATED SPECIFICATION SECTIONS 270500 AND 271100. REFER TO SPECIFICATION SECTION
- 270500 AND 271100 FOR ALL TCP/IP BASED CABLING REQUIREMENTS.

  1.2 IT SHALL BE THE RESPONSIBILITY OF CONTRACTOR TO PROVIDE ALL TECHNICAL ASSISTANCE INCLUDING BUT NOT LIMITED TO THE PREPARATION OF ALL SHOP DRAWINGS, SYSTEM CONFIGURATION, EQUIPMENT COORDINATION WITH THE DIVISION 27 CONTRACTOR AND ALL AFFECTED TRADES AS REQUIRED FOR THE PROPER INSTALLATION ALL EQUIPMENT, CONTROLS, DEVICES, CABLING, CABLE TERMINATIONS AND RELATED SYSTEM INTEGRATIONS.
- 1.3 REFER TO SPECIFICATION SECTION 280500 FOR ADDITIONAL INFORMATION ON SHOP DRAWINGS, INSTALLATION, WARRANTY, PROGRAMMING, TESTING AND ALL RELATED PROJECT REQUIREMENTS.
- 2. THE VIDEO DOOR INTERCOM SYSTEM SHALL BE A TCP/IP POE NETWORK-BASED COMMUNICATIONS AND SECURITY SYSTEM PLATFORM. AT THE MINIMUM THE SYSTEM SHALL INCLUDE THE FOLLOWING FUNCTIONS: VIDEO ENTRY SECURITY, INTERNAL COMMUNICATION, EMERGENCY STATIONS, AND PAGING.
- 3. ALL MASTER STATIONS SHALL BE ABLE TO UNLOCK DOORS REMOTELY ON A NETWORK, ASSIST ONSITE VISITORS FROM AN OFF SITE LOCATION, BROADCAST EMERGENCY ANNOUNCEMENTS, INTEGRATE WITH THE BUILDING'S VOIP TELEPHONE SYSTEM USING SIP BASED PROTOCOL AND COMMUNICATE USING A POE NETWORK.
- 4. THE SYSTEM SHALL BE BASED ON THE AI—PHONE IX SYSTEM PLATFORM.
  APPROVED EQUAL WILL BE ALLOWED. AT THE MINIMUM THE SYSTEM SHALL CONSIST
  OF THE FOLLOWING FEATURE AND/OR FUNCTIONS:
- 4.1 POWER SOURCE: POWER OVER ETHERNET (802.3AF) ALL MASTER AND REMOTE
- 4.2 NETWORK INTERFACE: 10 BASE—T / 100 BASE—TX ETHERNET (RJ—45).
  4.3 NETWORK PROTOCOLS: IPV4, IPV6, TCP, UDP, SIP, HTTP, HTTPS, MJPEG, RTSP, RTP, RTCP, IGMP, MLD, SMTP, DHCP, NTP, DNS.
- 4.4 COMMUNICATION: PUSH—TO—TALK (SIMPLEX)
  4.5 CAMERA: IP/TCP 1/4 INCH (6 MM) COLOR CMOS

STATIONS.

- 4.6 VIEW AREA: 2 FEET 2 INCHES (660 MM) VERTICAL X 3 FEET 1 INCH (940 MM) HORIZONTAL AT 20 INCHES (508 MM).
- 4.7 VIDEO STREAM: ONVIF PROFILE S.

  4.8 DOOR RELEASE: PROGRAMMABLE FORM C DRY CONTACT, 24V AC/ DC, 500MA
- (USE RY-24L FOR LARGER CONTACT RATING, WHICH REQUIRES 24V DC POWER SUPPLY) OR USE RY-IP44 WITH 4 MULTIPURPOSE RELAYS.

  4.9 CABLE TYPE: CATEGORY-6.
- 5. THE CONTRACTOR SHALL FURNISH AND INSTALL THE FOLLOWING SYSTEM COMPONENTS;
- 6. MASTER STATION SHALL BE TCP/IP ADDRESSABLE VIDEO STATION, WITH 3-1/2" LCD SCREEN, 6 PROGRAMMABLE DOOR RELEASE BUTTONS WITH A MINIMUM 500 STATION ADDRESS BOOK CAPACITY. THE STATION SHALL BE AI-PHONE MODEL
- 7. REMOTE INTERCOM STATION SHALL BE TCP/IP ADDRESSABLE VIDEO STATION, WITH FIXED COLOR CAMERA, PUSH TO TALK BUTTON, WEATHER RESISTANT SPEAKER. THE REMOTE SHALL BE WEATHER RESISTANT STAINLESS STEEL FACEPLATE AND FLUSH MOUNTED ON PEDESTALS. THE STATION SHALL BE AI-PHONE MODEL IX-DF.
- 8. ALL CABLE TERMINATIONS AND EQUIPMENT INSTALLATIONS SHALL BE IN ACCORDANCE WITH GOOD ENGINEERING PRACTICES AND BY ALL IEEE, EIA, NEC AND MANUFACTURER'S REQUIREMENTS. ALL CABLING SHALL COMPLY WITH ALL STATE AND LOCAL ELECTRICAL CODES AND SHALL TEST FREE FROM ALL GROUNDS, SHORTS, STRAY VOLTAGES AND EMI.
- 9. PROVIDE ALL EQUIPMENT CLEARANCES IN ACCORDANCE WITH NEC REQUIREMENTS. ARRANGE EQUIPMENT TO FACILITATE UNRESTRICTED ACCESS FOR MAINTENANCE AND SERVICE AROUND ALL EQUIPMENT, COMPONENTS AND/OR CABLE TERMINATIONS.
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- 8. REFER TO ALL DIVISION 26, 27, 28, RELATED DRAWINGS AND SPECIFICATION SECTIONS FOR ADDITIONAL INFORMATION ON SYSTEM INSTALLATIONS AND INTEGRATIONS, SUBMITTALS, WARRANTY AND CLOSE-OUT REQUIREMENTS.

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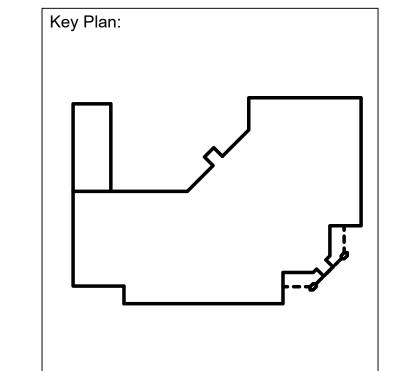
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Drawn By: AJF Checked By: AJF

Drawing Title:

SECURITY SYSTEMS RISER DIAGRAM

Drawing Number:

ES301

SECURITY SYSTEMS RISER DIAGRAM

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